

01) EXISTING PARKING AREA

02) EXISTING CURB

03) EXISTING SIDEWALK

(04) EXISTING ELEC. TRANSFORMER(05) EXISTING WATER SERVICE ENTRANCE

06) NEW CURB

07) NEW SIDEWALK

08) NEW STAIRS

09 NEW DUMPSTER ENCLOSURE, REFER TO 4/A1.6

10 NEW VAN ACCESSIBLE PARKING SPACE

11) NEW PARKING SPACES

12) NEW MOTORCYCLE PARKING SPACE

13) NEW CONCRETE CURB AT EXISTING PLANTER

NEW MONUMENT SIGN AT EXISTING SIGN LOCATION, REFER TO 1/A1.6

15) NEW SITE FENCE, REFER TO 2/A1.6

16 PROPERTY LINE

(17) EXISTING MOTORCYCLE PARKING SPACE

18) NEW BICYCLE PARKING

(19) NEW LONG-TERM BICYCLE PARKING

ARE

BUILDING AREA

1ST FLOOR AREA

19,071 GSF

2ND FLOOR AREA

19,953 GSF

TENANT PATIO - UPPER

494 GSF

TOTAL BUILDING AREA

39,024 GSF

COMMON AREAS

COMMON PATIO - LOWER

COMMON PATIO - UPPER

COMMON PATIO - EAST 2,760 GSF

TOTAL COMMON PATIOS 5,950 GSF

LEASABLE AREA

1ST FLOOR RESTAURANT 5,812 GLA

2ND FLOOR RESTAURANT 3,718 GLA

OFFICE 11,165 GLA

SUB-TOTALS 9,530 GLA

20,444 GLA

TOTAL 29,974 GLA

RETAIL

PARKING

RESTAURANT SPACES
6.6 MIN - 9.0 MAX SPACES / 1,000 SF GLA
(9,530 GLA / 1000 SF) x 6.6 MIN. = 62.9 REQ'D

OFFICE/RETAIL SPACES

3.0 MIN - 7.0 MAX SPACES / 1,000 SF GLA
(20,444 GLA / 1000 SF) x 3.0 MIN. = 61.3 REQ'D

TOTAL SPACES REQUIRED = 124

TOTAL SPACES PROVIDED = 121

ACCESSIBLE PARKING

101-150 SPACES, MIN. SPACES REQ'D

SPACES PROVIDED

VAN ACCESSIBLE PARKING

1 REQ'D / 6 ACCESSIBLE SPACES PROVIDED = 1

SPACES PROVIDED = 1

MOTORCYCLE PARKING

1 REQ'D / 50 PROVIDED PARKING
109 SPACES / 50 SPACES PER MOTOCYCLE = 2
TOTAL PROVIDED = 3

BICYCLE PARKING

BICYCLE SPACE REQ'D:

2 MIN. + 0.4 (29,974 GLA / 1000 SF) = 14

SHORT-TERM PARKING REQ'D: 0.85 x 14 = 12

LONG-TERM PARKING REQ'D: 0.15 x 14 = 2

TOTAL SHORT-TERM SPACES PROVIDED = 18

TOTAL LONG-TERM SPACES PROVIDED = 3

DELIVERY LOADING SPACE

DELIVERY LOADING SPACES REQ'D:
39,024 GSF / 25,000 SF PER SPACE = 2

TOTAL SPACES PROVIDED = 0

LANDSCAPE LEGEND

NEW TREE (REFER TO LANDSCAPE PLAN)

NEW BUSH (REFER TO LANDSCAPE PLAN) PRELIMINARY
NOT FOR
CONSTRUCTION

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JE DATE 02.01.2024

JECT NO. 724

WN BY KSH

CKED BY JRM


REVISIONS

465 GSF 2,725 GSF

9,279 GLA

ST MAMMOTH LAKES, CA 93546

SITE PLAN

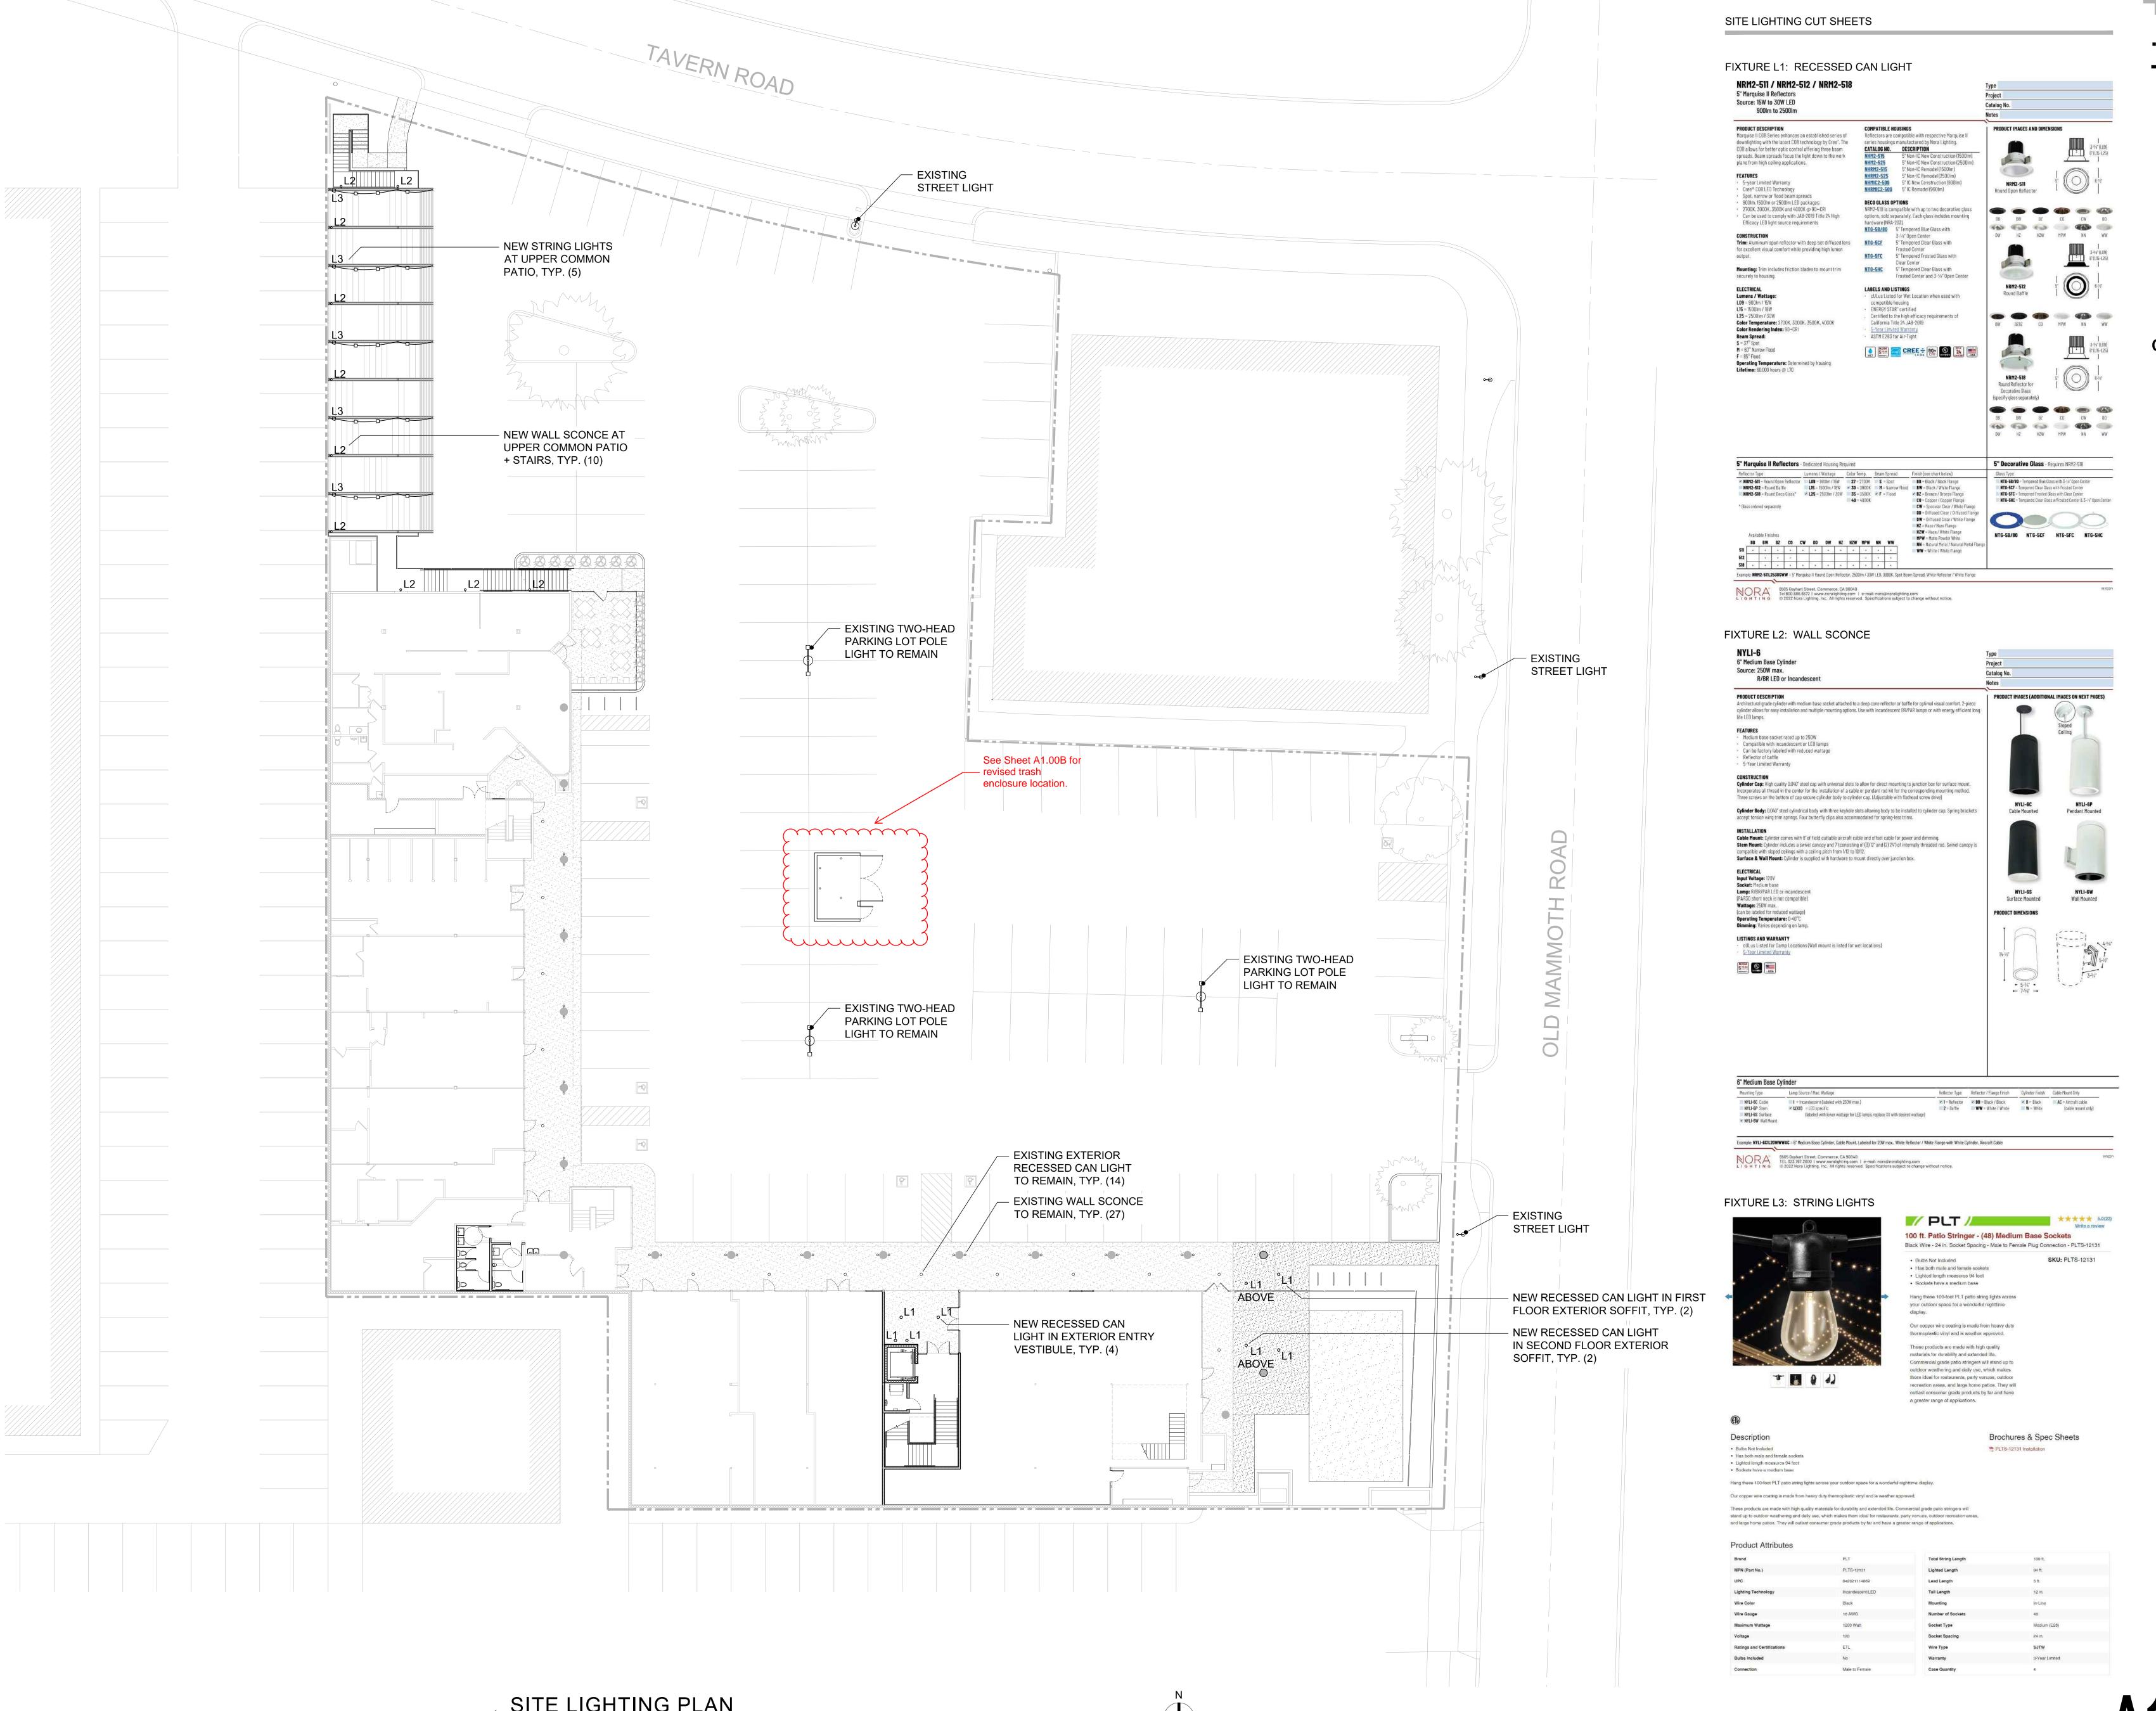

Ë cla epp

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ISSUE DATE PROJECT NO. CHECKED BY REVISIONS



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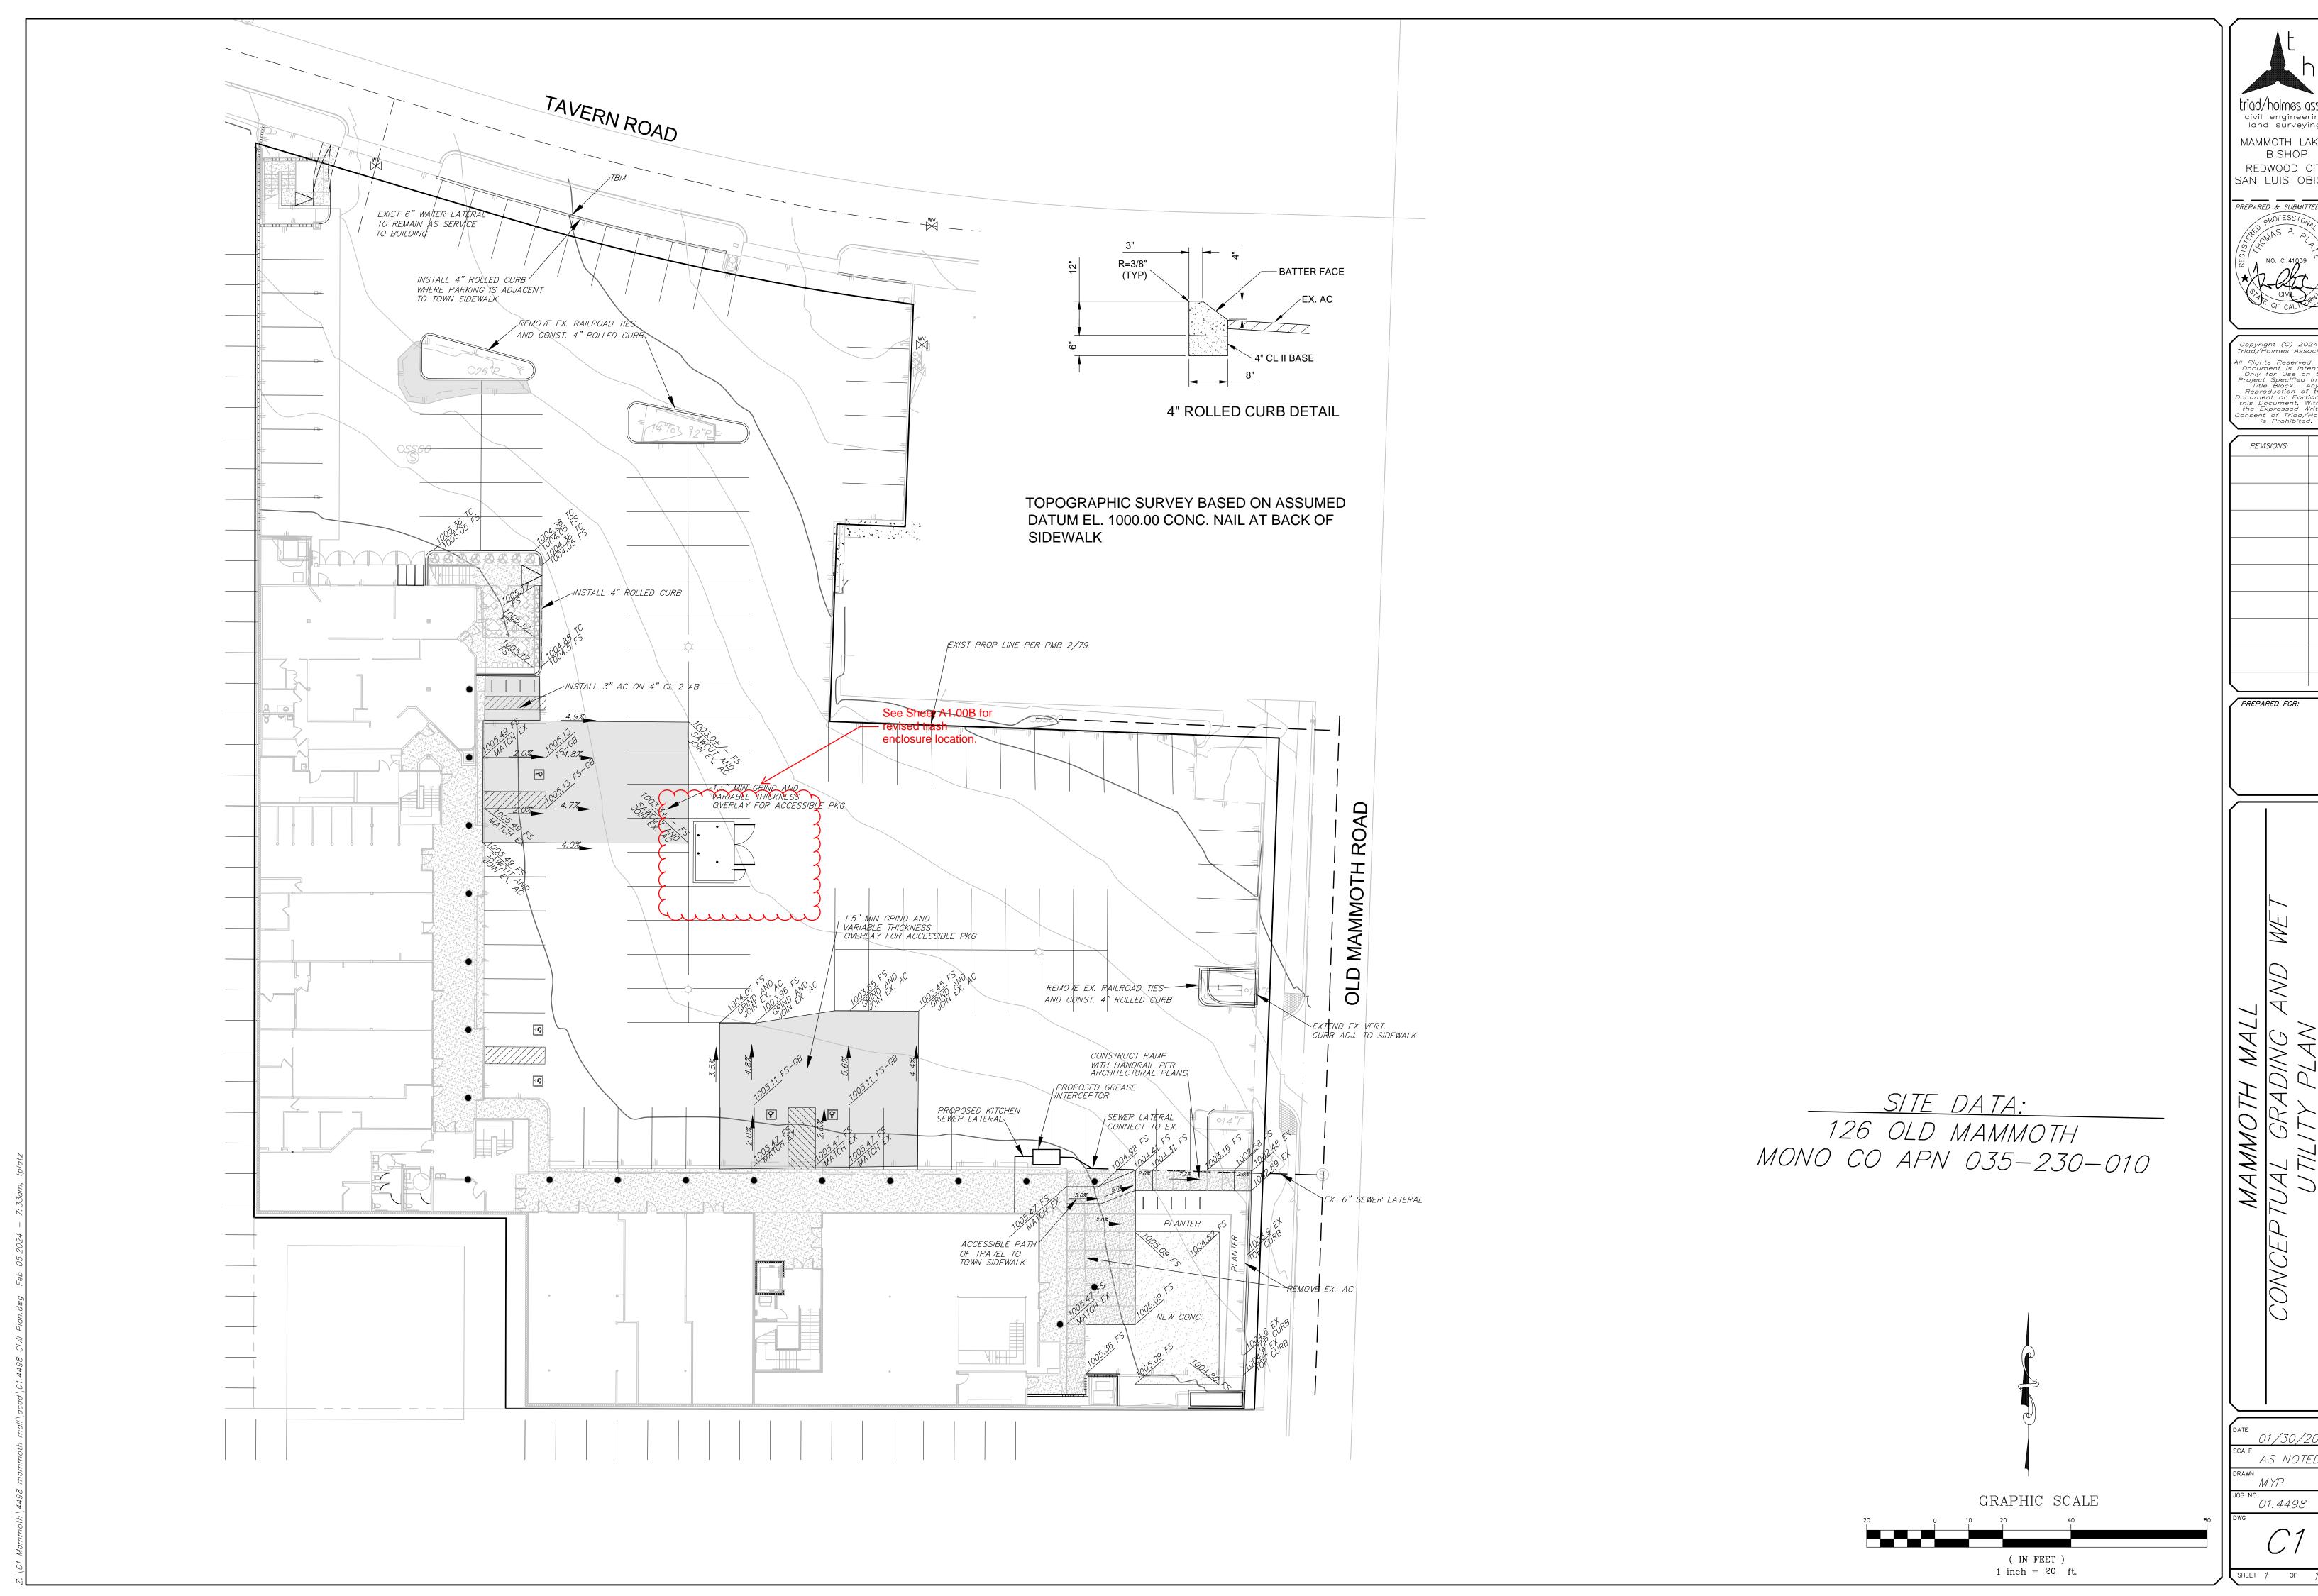
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SSUE DATE 03.08.2024
ROJECT NO. 724
RAWN BY KSH
HECKED BY JRM

REVISIONS CD PROGRESS SET

POST MAMMOTH LAKES, CA 93546

A1.00B



triad/holmes assoc civil engineering land surveying MAMMOTH LAKES REDWOOD CITY SAN LUIS OBISPO PREPARED & SUBMITTED BY:

REVISIONS: BY:

01/30/2024 AS NOTED

GROUND LEVEL

1" = 20'

0 20

40

## CONCEPT PLANTS LEGEND



EXISTING CONIFER



DECIDUOUS TREES Such as:

Malus floribunda / Flowering Crabapple Populus tremuloides / Quaking Aspen Sorbus aucuparia / Mountain Ash

SMALL SHRUBS
Such as:

Such as:
Eriogonum umbellatum / Sulfurflower Buckwheat
Fallugia paradoxa / Apache Plume
Lavandula angustifolia 'Hidcote' / Hidcote English Lavender
Pinus mugo / Mugo Pine
Potentilla fruticosa / Bush Cinquefoil
Ribes aureum / Golden Currant
Ribes cereum / Wax Currant

MEDIUM SHRUBS

Such as:
Cornus sericea 'Baileyi' / Bayley's Red Twig Dogwood
Sambucus nigra 'Gerda' / Black Beauty® Elderberry
Syringa vulgaris / Common Lilac

PERENNIAL COLOR

Such as:
Achillea millefolium / Common Yarrow
Allium x 'Millenium' / Millenium Ornamental Onion
Cerastium tomentosum / Snow In Summer
Coreopsis grandiflora / Tickseed
Delphinium glaucum / Sierra Larkspur
Echinacea purpurea / Coneflower
Eschscholzia californica / California Poppy
Hemerocallis x / Hybrid Daylily
Linum lewisii / Lewis Flax
Nepeta x faassenii / Catmint
Penstemon strictus / Rocky Mountain Penstemon
Phlox subulata / Creeping Phlox
Sesleria autumnalis / Autumn Moor Grass



ROW PLANTING

## LANDSCAPE NOTES

The planting design has been planned in accordance with the requirements of the Town of Mammoth Lakes Water Efficient Landscape Ordinance and Design Guidelines.
All new planting shall be irrigated by an automatic, water-efficient, drip irrigation system with areas of like water use hydrozoned for maximum efficiency.
All planting areas shall receive a 3" layer of bark mulch.
Final landscape plans will include the required landscape documentation package and water-use calculations.
No new landscape lighting is proposed.

# LANDSCAPE DESIGN STATEMENT

This landscape plan proposes plant materials which are either native or adaptive to the Sierra Nevada region. Most of these plants have a high degree of drought tolerance and will require moderate or low amounts of supplemental irrigation and fertilizers or pesticides. Proposed plants will blend and harmonize well with the Mammoth Lakes area and will provide habitat value for native wildlife. Proposed shrubs, groundcovers, bunch-grasses and blooming perennials will provide color, texture, and seasonal interest. Planting areas have been hydrozoned (i.e. placed into groupings with similar water requirements). The majority of the planting areas will be in the low-water-use hydrozone, with plants with higher water needs, such as aspens and dogwoods, limited to small areas.



SUBMITTAL DESIGN REVIEW

DATE 2/2/24

REVISIONS

NO. DESCRIPTION DATE

PRELIMINARY LANDSCAPE PLAN OUTPOST MAMMOTH

126 OLD MAMMOTH ROAD MAMMOTH LAKES, CA





126 Old Mammoth Rd Mammoth Lakes CA 93546



# repp+mclain

DESIGN AND CONSTRUCTION

2502 N 1<sup>ST</sup> Ave Tucson AZ 85719 520.791.7035 reppmclain.com



EXISTING VIEW FROM OLD MAMMOTH ROAD

0



### MAMMOTH LAKES ADOPTED CODES

TOGETHER WITH CHAPTER 1 AND THE ADOPTED APPENDICES THERETO, AS DEVELOPED BY THE INTERNATIONAL CODE COUNCIL, IS ADOPTED BY REFERENCE AS THE BUILDING CODE OF THE TOWN.

2019 CALIFORNIA PLUMBING CODE

TOGETHER WITH CHAPTER 1 AND THE ADOPTED APPENDICES THERETO, AS DEVELOPED BY THE INTERNATIONAL ASSOCIATION OF PLUMBING AND MECHANICAL OFFICIALS, IS ADOPTED BY REFERENCE AS THE PLUMBING CODE OF THE

2019 CALIFORNIA ELECTRICAL CODE

TOGETHER WITH ARTICLE 89 AND ALL OTHER ADOPTED CHAPTERS AND ARTICLES THERETO, AS PROMULGATED BY THE NATIONAL FIRE PROTECTION ASSOCIATION, IS ADOPTED BY REFERENCE AS THE ELECTRICAL CODE OF THE TOWN.

2019 CALIFORNIA MECHANICAL CODE

TOGETHER WITH CHAPTER 1 AND ALL OTHER ADOPTED CHAPTERS AND THE APPENDICES THERETO, AS DEVELOPED BY THE INTERNATIONAL ASSOCIATION OF PLUMBING AND MECHANICAL OFFICIALS, IS ADOPTED BY REFERENCE AS THE MECHANICAL CODE OF THE TOWN.

2019 CALIFORNIA ADMINISTRATIVE CODE

AS DEVELOPED BY THE INTERNATIONAL CODE COUNCIL IS ADOPTED BY REFERENCE AS THE ADMINISTRATIVE CODE OF THE TOWN.

2019 CALIFORNIA HISTORICAL BUILDING CODE

AS ADOPTED BY THE STATE OF CALIFORNIA, IS ADOPTED BY REFERENCE AS THE HISTORICAL BUILDING CODE OF THE TOWN.

2019 CALIFORNIA EXISTING BUILDING CODE

AS ADOPTED BY THE STATE OF CALIFORNIA, IS ADOPTED BY REFERENCE AS THE EXISTING BUILDING CODE OF THE TOWN

2019 CALIFORNIA ENERGY CODE AS ADOPTED BY THE STATE OF CALIFORNIA, IS ADOPTED BY REFERENCE AS THE ENERGY CODE OF THE TOWN.

2018 INTERNATIONAL PROPERTY MAINTENANCE CODE

AS DEVELOPED BY THE INTERNATIONAL CODE COUNCIL, IS ADOPTED BY REFERENCE AS THE PROPERTY MAINTENANCE CODE OF THE TOWN.

CALIFORNIA RESIDENTIAL CODE

TOGETHER WITH CHAPTER 1, APPENDIX J ("EXISTING BUILDINGS AND STRUCTURES"), AND APPENDIX Q ("TINY HOUSES") AS DEVELOPED BY THE INTERNATIONAL CODE COUNCIL. ADOPTED BY REFERENCE AS THE RESIDENTIAL CODE OF THE TOWN.

2019 CALIFORNIA GREEN BUILDING STANDARDS CODE AS ADOPTED BY THE STATE OF CALIFORNIA, IS ADOPTED BY REFERENCE AS THE GREEN BUILDING STANDARDS CODE OF THE TOWN.

2019 CALIFORNIA REFERENCE STANDARDS CODE AS ADOPTED BY THE STATE OF CALIFORNIA, IS ADOPTED BY REFERENCE AS THE REFERENCE STANDARDS CODE OF THE TOWN.

2019 CALIFORNIA FIRE CODE

AS ADOPTED BY THE STATE OF CALIFORNIA IS ADOPTED BY REFERENCE AS THE FIRE CODE OF THE TOWN

## PROJECT INFORMATION

PROJECT LOCATION: OUTPOST MAMMOTH MALL 126 OLD MAMMOTH ROAD MAMMOTH LAKES, CALIFORNIA 93546

PARCEL NUMBER:

PARCEL 035-230-010-000

SITE AREA (EXISTING): 1.88 ACRES (81,893 SF)

BUILDING AREA / TYPE: FIRST FLOOR (EXISTING)
EXTERIOR BUILDING AREA:
COMMON PATIO - LOWER (SEASONAL):
COMMON PATIO - EAST (SEASONAL):

SECOND FLOOR (EXISTING)
EXTERIOR BUILDING AREA:
TENANT PATIO - UPPER (SEASONAL):
COMMON PATIO - UPPER (SEASONAL): 19,939 GSF 494 GSF 2,749 GSF

BUILDING TYPE VB (EXISTING) AUTOMATIC FIRE SPRINKLER SYSTEM (EXISTING SYSTEM) D (DOWNTOWN)
GENERAL PLAN LAND USE CLASSIFICATION - COMMERCIAL 2 (C-2)

COMMERCIAL DISTRICT PRIMARY ACTIVE FRONTAGE - ALONG OLD MAMMOTH ROAD

SECONDARY ACTIVE FRONTAGE - ALONG TAVERN ROAD

RETAIL USE CLASSIFICATIONS: RESTAURANT, CAFÉ, COFFEE SHOP P (PERMITTED) GENERAL RETAIL P (PERMITTED)

A (ADMINISTRATIVE PERMIT REQUIRED BAR / TAVERN / NIGHTCLUBS ARTISAN SHOP P (PERMITTED) P (PERMITTED) TASTING ROOM

P(7) (LIMITED TO WALK-IN CLIENTELE WHEN ALONG THE GROUND FLOOR ALONG DESIGNATED ACTIVE FRONTAGE) PERSONAL SERVICES P (PERMITTED)

LOT SIZE:

LOT DEPTH

LOT AREA (CORNER)

LOT WIDTH (CORNER)

11,000 SF (MINIMUM) 90' (MINIMUM) 100' (MINIMUM) MAXIMUM SLOPE FOR BUILDING SITE 20%

2.0 (MINIMUM)

DESIGNATED ACTIVE FRONTAGE AREAS

PROPERTY LINE OR 15' FROM BACK OF CURB, WHICHEVER IS GREATER (B) (NEW DEVELOPMENT SHALL PROVIDE STREET FRONTAGE IMPROVEMENTS)

INTERIOR SIDE AND REAR 10' (B) PROJECTIONS INTO SETBACKS

BUILD-TO REQ.: SECONDARY ACTIVE FRONTAGE MINIMUM 40% OF LINEAR STREET FRONTAGE (C)

15' SETBACK BUFFER AREA SCREENING W/ LANDSCAPE N/A ADJACENT OLD MAMMOTH ROAD AREA RETAIL TO RESIDENTIAL CLEARWATER SPECIFIC PLAN

MINIMUM 40% OF LINEAR STREET FRONTAGE (C)

SECONDARY ACTIVE FRONTAGE MAXIMUM OVERALL BUILDING HEIGHT

SCREENING:

MINIMUM BUILDING FACE HEIGHT 20' (PRIMARY ACTIVE FRONTAGE) MAXIMUM BUILDING FACE HEIGHT 25' FOR 60% (D) 35' FOR 20% 45' FOR 20% MINIMUM 10' FROM BUILDING FACE BELOW (D)

PARKING + LOADING: SETBACK FROM STREET PROPERTY LINE 20 FT

SETBACK FROM BUILDINGS 8 FT (5' SIDEWALK + 3' ZONE 1 PARKING (SPACES / 1,000 SF GLA) RETAIL USE CLASSIFICATION RESTAURANT ADA PARKING

PER CALIFORNIA BUILDING STANDARDS CODE PARKING LOT W/ 50 OR MORE MOTORCYCLE PARKING MIN 1 SPACE (4 FT X 7 FT) BICYCLE PARKING LOADING SPACE GENERAL RETAIL

COMMERCIAL DISTRICT ADDITIONAL STANDARDS:

(1) FOR EACH 25,000 SF PLUS ADDITIONAL AS REQUIRED BY REVIEW AUTHORITY NEED LOADING SPACE SIZE ? TRASH / RECYCLE PROVIDED

SNOW STORAGE (60% OF PARKING) PROPANE TANKS + DUMPSTERS FENCES + WALLS EXTERIOR LIGHTING DESIGN REVIEW

SIGNS LANDSCAPING COMMERCIAL DISTRICT SUPPLEMENT STANDARDS:

SHEET INDEX

TS TITLE SHEET A1.0 EXISTING SITE PLAN A1.1 SITE PLAN

A1.2 EXISTING FIRST FLOOR PLAN A1.3 FIRST FLOOR PLAN A1.4 EXISTING SECOND FLOOR PLAN

A1.5 SECOND FLOOR PLAN A1.6 SIGNAGE + SITE DETAILS

A2.1 ELEVATIONS A3.0 EXISTING BUILDING SECTIONS

A3.1 BUILDING SECTIONS A3.2 ENLARGED BUILDING SECTIONS

MAX BLOCK LENGTH BUILDING ORIENTATION + ENTRANCE BUILDING TRANSPARENCY (60% WITH 20') 126

SHEET



04) EXISTING ELEC. TRANSFORMER

10 NEW VAN ACCESSIBLE PARKING SPACE

12 NEW MOTORCYCLE PARKING SPACE

13) NEW CONCRETE CURB AT EXISTING PLANTER

14 NEW MONUMENT SIGN AT EXISTING SIGN LOCATION

81,893 SF 19,071 GSF 19,939 GSF TENANT PATIO - UPPER 494 GSF 39,504 GSF 655 GSF

RESTAURANT SPACES 6.6 MIN / 9.0 MAX SPACES / 1,000 SF GLA TOTAL AREA = 11,279 GSF / 6.6 MIN. = 74.4 REQ'D

RETAIL SPACES
3.0 MIN / 7.0 MAX SPACES / 1,000 SF GLA
TOTAL AREA = 20,563 GSF / 3.0 MIN. = TOTAL SPACES REQUIRED TOTAL SPACES PROVIDED = 109

ADA PARKING 101-150 SPACES, MIN. SPACES REQ'D SPACES PROVIDED

**PRELIMINARY** NOT FOR CONSTRUCTION

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ISSUE DATE 10.04.2023 PROJECT NO. 724

2,749 GSF

2,760 GSF

6,164 GSF


OUTPOST MAMMOTH MAL 126 OLD MAMMOTH ROAD, MAMMOTH LAKES, CA 93546

SITE PLAN

ISSUE DATE 10.04.20
PROJECT NO. 7
DRAWN BY KS
CHECKED BY JF

REVISIONS

OUTPOST MAMMOTH MALL
126 OLD MAMMOTH ROAD, MAMMOTH LAKES, CA 93546
FIRST FLOOR PLAN

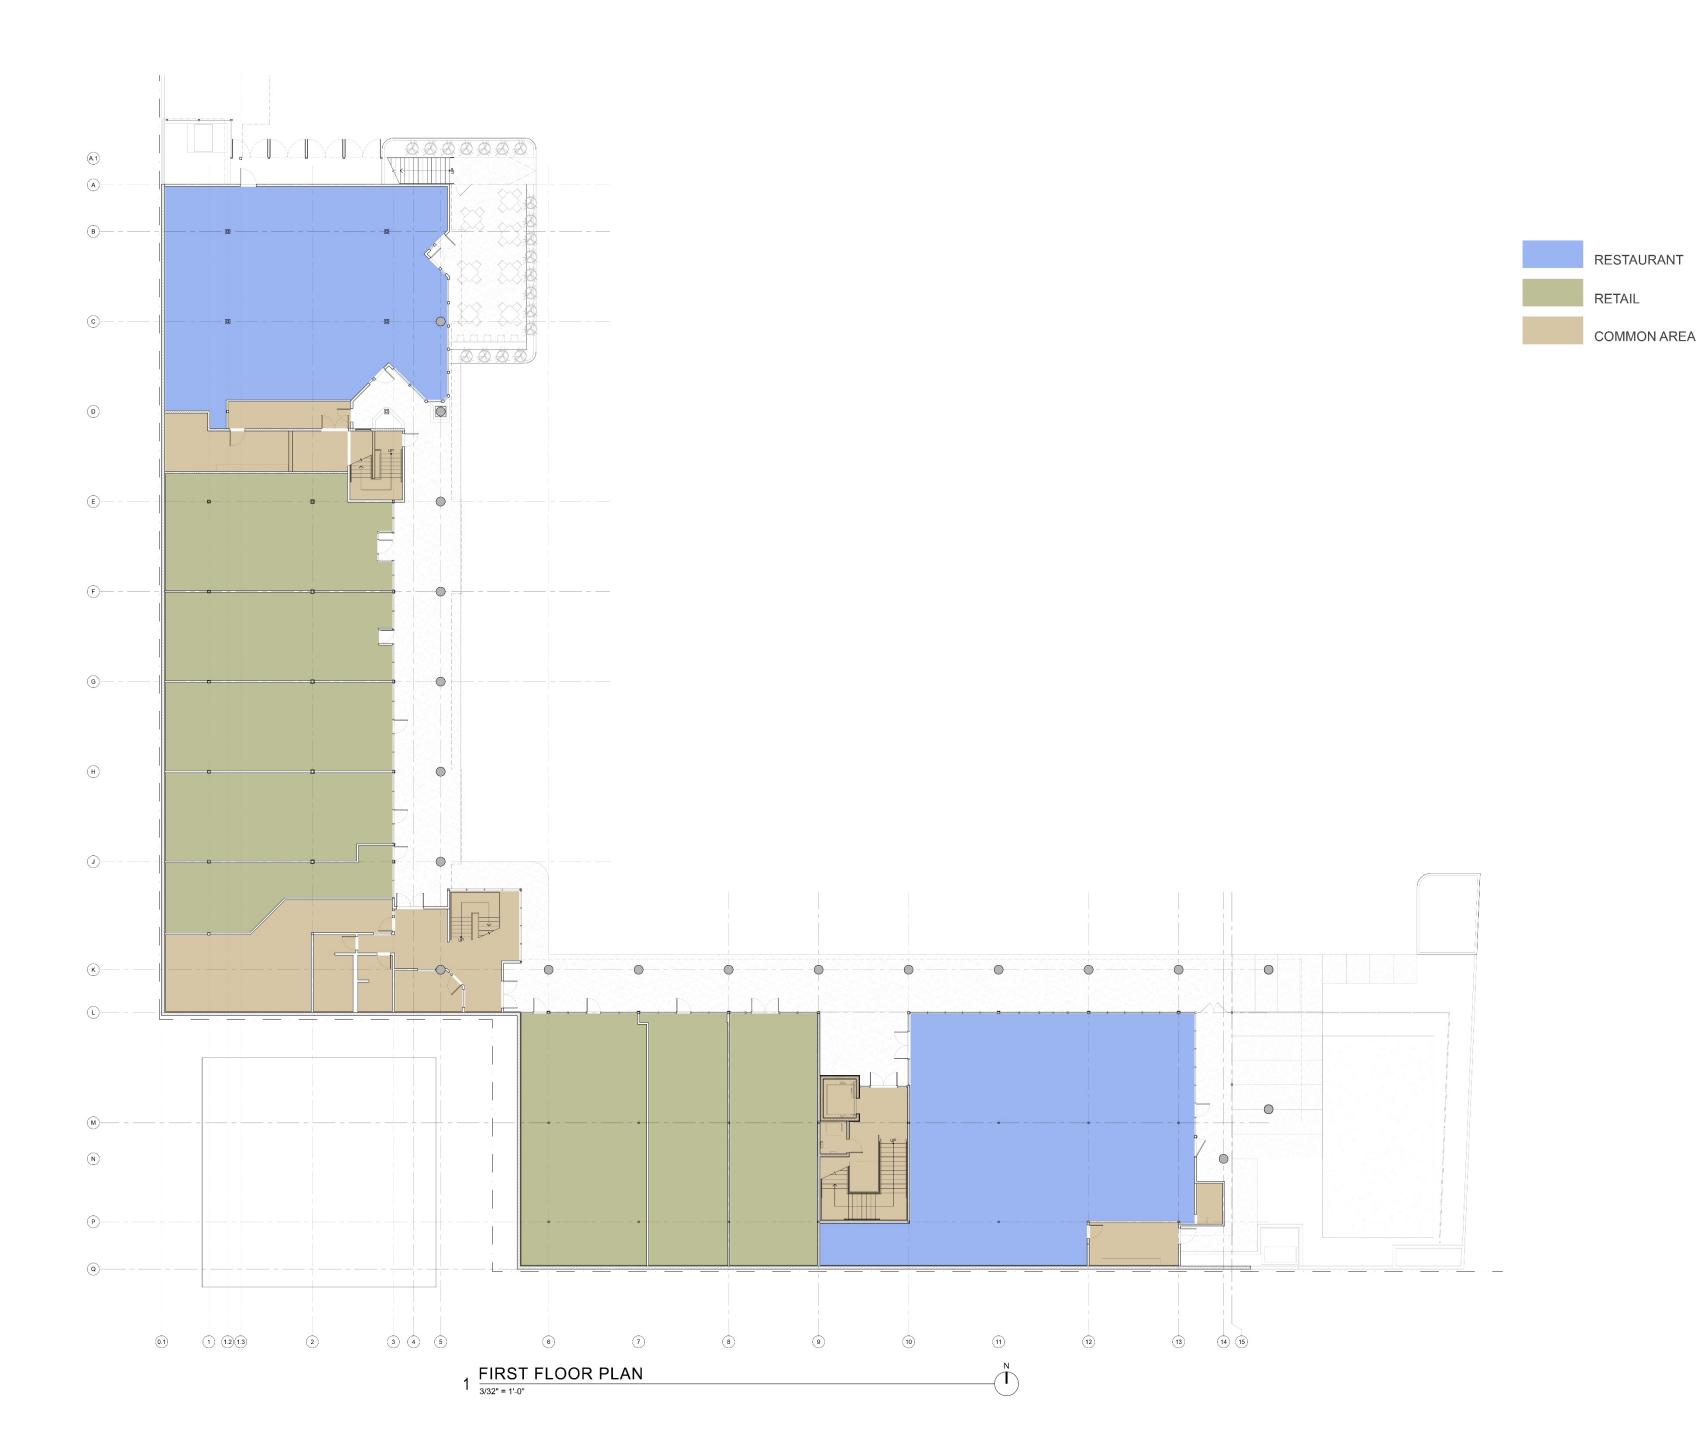

RESTAURANT

COMMON AREA


RETAIL

ISSUE DATE PROJECT NO. CHECKED BY

OUTPOST MAMMOTH MAL

126 OLD MAMMOTH ROAD, MAMMOTH LAKES, CA 93546

SECOND FLOOR PLAN

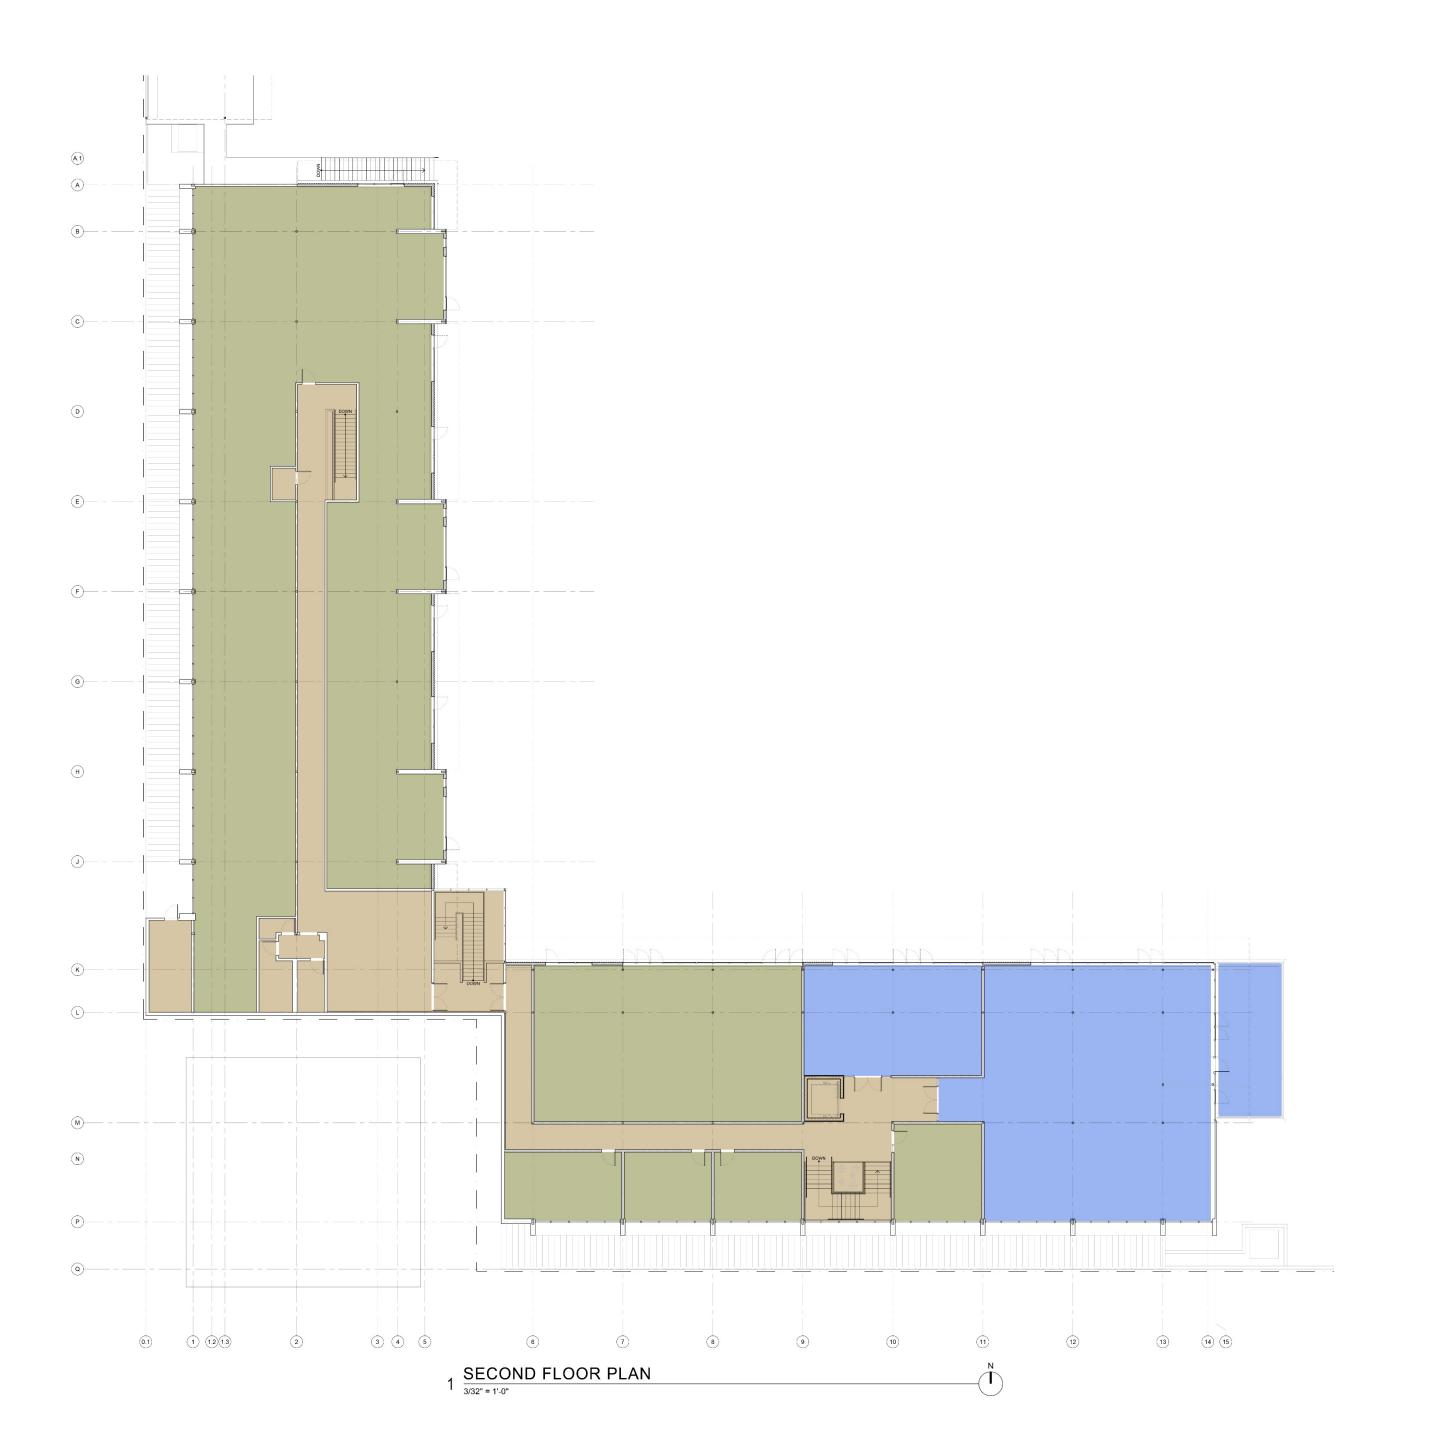

NEW BUILDING ELEVATION (EAST)

1/8" = 1'-0"

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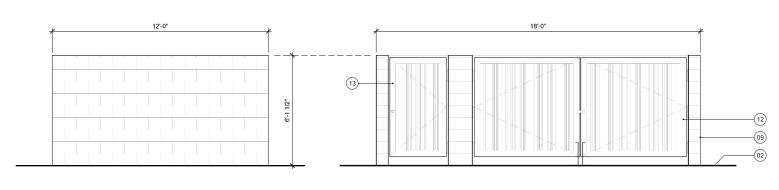
**PRELIMINARY** NOT FOR CONSTRUCTION

ISSUE DATE 10.04.2023 PROJECT NO. DRAWN BY CHECKED BY

MAMMOTH LAKES, CA 93546 OUTPOS 126 OLD MAMMOTH


9'-0" **♦** 

ELEVATIONS




SIDE ELEVATION FRONT ELEVATION

DUMPSTER ENCLOSURE

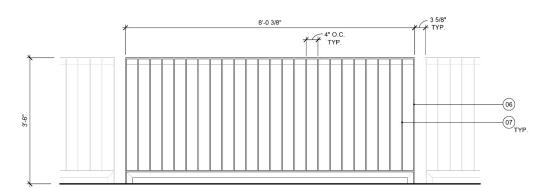

2ND FLOOR F.F. LAKE BREWERY 9'-0" **&** 

3 TYPICAL TENANT SIGNAGE
3/8" = 1'-0"

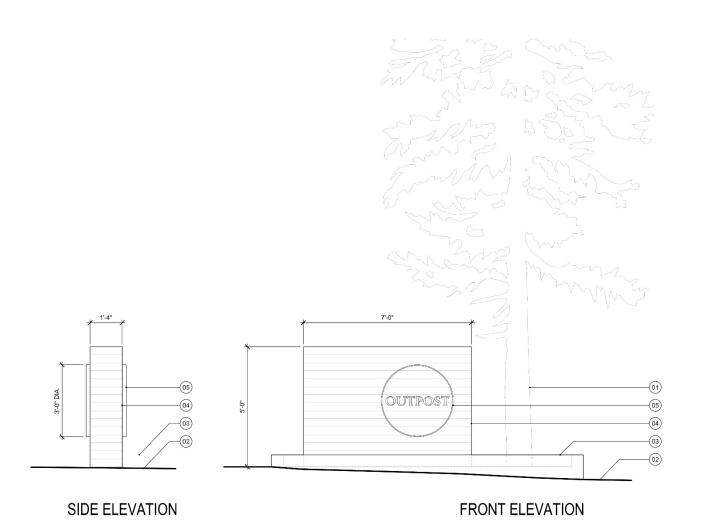

1 NEW MONUMENT SIGN AT OLD MAMMOTH ROAD  $_{1/2"=1'\cdot0"}$ 

SIGNAGE + SITE DETAILS KEY NOTES

01) EXISTING TREE

02 EXISTING GRADE

CONCRETE CURB AT EXISTING PLANTER LOCATION

BOARD-FORMED CONCRETE MONUMENT SIGN

05 BACKLIT CHANNEL SIGNAGE

07) 3/8" x 2" STEEL FLAT BAR PICKETS AT 4" O.C., PAINT

09) 8" CONCRETE MASONRY DUMPSTER ENCLOSURE

(10) 6" CONCRETE SLAB

4" DIAMETER SCHEDULE 40 PIPE BOLLARD (4 1/2" O.D.) INSIDE ENCLOSURE, FILL WITH CONCRETE, PAINT

(12) 4" x 2" x 1/4" TUBE STEEL GATE FRAME W/ 1 1/2"
B-DECK INFILL PANEL, WELD STEEL HINGES TO WELD
PLATES CAST IN WALL, HASP LATCH FOR PAD LOCK,
CANE BOLTS AT PANEL BOTTOM, PAINT

(13) 4" x 2" x 1/4" TUBE STEEL DOOR FRAME W/ 1 1/2" B-DECK INFILL PANEL, WELD STEEL HINGES TO WELD PLATES CAST IN WALL, DEADBOLT LOCK, PAINT

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ISSUE DATE PROJECT NO.

OUTPOST MAMMOTH MALL 126 OLD MAMMOTH ROAD, MAMMOTH LAKES, CA 93546

2 TYPICAL SITE FENCE ELEVATION
3/8" = 1'-0"

SIGNAGE + SITE D



VIEW FROM OLD MAMMOTH ROAD



VIEW FROM OLD MAMMOTH ROAD



VIEW FROM OLD MAMMOTH ROAD



VIEW FROM ENTRY



AERIAL VIEW FROM OLD MAMMOTH ROAD





VIEW FROM PARKING



VIEW FROM PARKING



VIEW FROM OLD MAMMOTH ROAD



VIEW FROM TAVERN ROAD



VIEW FROM PARKING AREA



VIEW FROM PARKING AREA



P1 DUNN EDWARDS, COLOR DE6227 MUSLIN



P2 DUNN EDWARDS, COLOR DET680 ESPRESSO MACCHIATO



WD1 GLULAM BEAM, DOUGLAS FIR, SANSIN BORACOL CLEAR SEALER



**STC** STUCCO SIDING, SAND FINISH, COLOR: DUNN EDWARDS, DE6368 WALRUS



PELLA IMPERVIA FIBERGLASS CASEMENT WINDOW, LOW E, HIGH ALTITUDE, BLACK FRAME, HORIZONTAL GRILL (REFER TO **ELEVATIONS**)




PELLA IMPERVIA FIBERGLASS PICTURE WINDOW, LOW E, HIGH ALTITUDE, **BLACK FRAME** 











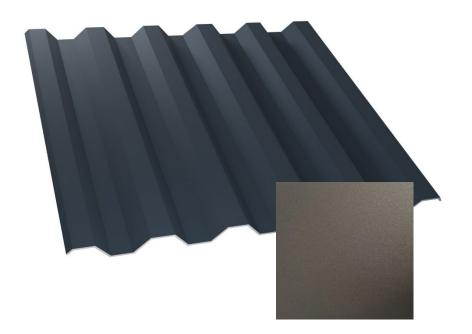

M3 METAL SIDING PANEL, AEP SPAN HR-36 PANEL WITH EXPOSED FASTENERS, 36" PANEL WIDTH, 1 1/2" RIB HEIGHT, COLOR: MIDNIGHT BRONZE

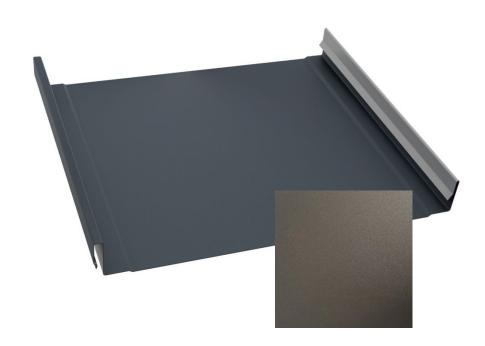

M1 M2 STANDING SEAM METAL ROOF+SIDING, AEP SPAN DESIGN SPAN HP PANEL WITH CLIPS AND CONCEALED FASTENERS, 18" PANEL WIDTH, 1 3/4" RIB HEIGHT, COLOR: MIDNIGHT BRONZE

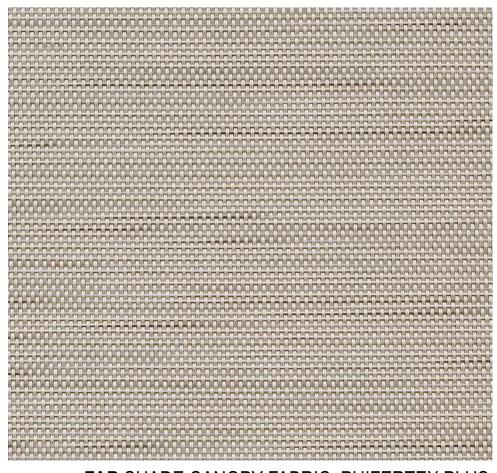

FAB SHADE CANOPY FABRIC, PHIFERTEX PLUS WOVEN VINYL-COATED POLYESTER SHADE FABRIC, COLOR: MADRAS TWEED PUTTY, NFC



**WD2** WOOD SLAT, DOUGLAS FIR, SANSIN **BORACOL CLEAR SEALER** 





